MTE GREEN STACKER - NEW CONSTRUCTION HWY 47 NORTH N3580, BIA RTE 427 | NEOPIT, WI 54150

	SHEET INDEX		BUILDING CODE SUMMARY
SHEET T1.0 C100 C101 C102	DESCRIPTION TITLE AND CODE SHEET CIVIL SHEET NAME SHEET NAME SHEET NAME	BASED ON THE	WISCONSIN COMMERCIAL BUILDING CODE (2015 INTERNATIONAL BUILDING CODE w/ WI AMENDMENTS) 2015 INTERNATIONAL EXISTING BUILDING CODE 2009 ANSI A117.1 ACCESSIBILITY CODE ALL OTHER CODES AND ORDINANCES AS REFERENCED BY THE ABOVE CODES
C103 C104	SHEET NAME SHEET NAME	BUILDING AREA	TOTAL BUILDING AREA: 9,396 S.F.
	ARCHITECTURAL	OCCUPANCY	(F-1) FACTORY INDUSTRIAL, MODERATE HAZARD
SP1.0 D1.0 D1.1	SITE PLAN DEMOLITION PLAN - PHASE 1 DEMOLITION PLAN - PHASE 2	OCCUPANCY SEPARATION	NONE
A1.0 A1.1	FLOOR PLAN ROOF PLAN	CONSTRUCTION TYPE	II-B
A2.0 A3.0	EXTERIOR ELEVATIONS BUILDING SECTIONS	SPRINKLER SYSTEM	NOT REQUIRED PER IBC 903
A6.0	SCHEDULES	FIRE ALARM	NOT REQUIRED PER IBC 907
S0.0	STRUCTURAL SHEET NAME		BOTTLED WATER WILL BE PROVIDED IN LIEU OF DRINKING FOUNTAIN, PER SPS 362.2902
S0.1 S1.0 S2.0 S3.0 S3.1 S4.0 S5.0 M100 M101 M102 M103 M104 M103 M104 M105 E100 E101 E102 E103 E104 E105	SHEET NAME SHEET NAME	THE CONTRACTOR(S) SI PRECAUTIONS & PROGE 2. ARCHITECT/DESIGNER SI ISSUES ARISING DUE GO SHOULD ENDEAVOR TO 3. GC, SUBCONTRACTORS OMISSIONS, OR DEFECT INSTALLING WORK. 4. SITE DIMENSIONS ARE T SHALL BE NOTIFIED OF A 5. MECH, ELEC, PLUMB & F CODES, ORDINANCES & THE ARCHITECT ASSUM 6. ALL MECH, ELEC, PLUME MAINTANANCE/OPPERA 7. THE INSTALLATION AND MANUFACTURER'S STAN MANUFACTURER'S STAN	B & FIRE PROTECTION SYSTEMS/EQUIP. SHALL BE MAINTAINED ACCORDING TO NDARDS. BLDG. OWNER SHALL ASSUME FULL RESPONSIBILITY FOR TION UPON OCCUPANCY. • EXECUTION OF ALL MATERIALS SHALL BE IN ACCORDANCE WITH THE NDARDS AND SPECIFICATIONS. ALL MEANS & METHODS OF CONSTRUCTION TO BE
P100 P101 P102 P103 P104 P105	PLUMBING SHEET NAME	BY THE INTERNATIONAL DISTANCE OF 75' TO AN LOCATIONS WERE THEY TYPICALLY ALONG PATH VISUAL OBSTRUCTION O EXTINGUISHER LOCATIO IS NOT MORE THAT 5'-0" THAT ITS TOP IS NOT MO BOTTOM OF HAND HELD LOCAL FIRE DEPT. & OW 9. ALL CONCRETE FLAT WO CURING COMPOUND. RE	ITY OF THE GC. GUISHERS SHALL BE PROVIDED IN OCCUPANCIES AND LOCATIONS AS REQUIRED FIRE CODE. INSTALLATION LOCATIONS SHALL HAVE A MAXIMUM TRAVEL Y EXTINGUISHER. EXTINGUISHERS SHALL BE LOCATED IN CONSPICUOUS (WILL BE READILY ACCESSIBLE AND IMMEDIATELY AVAILABLE FOR USE, HS OF TRAVEL. EXTINGUISHERS SHALL NOT BE OBSTRUCTED FROM VIEW, IF CAN NOT BE AVOIDED ANOTHER MEANS SHALL BE PROVIDED TO INDICATE THE DNS. EXTINGUISHERS NOT EXCEEDING 40" SHALL BE INSTALLED SO THAT ITS TOP ABOVE THE FLOOR, EXTINGUISHERS EXCEEDING 40" SHALL BE INSTALLED SO ORE THAN 3'-6" ABOVE THE FLOOR. THE CLEARANCE BETWEEN THE FLOOR AND O UNITS SHALL NOT BE LESS THAN 4". VERIFY EXTINGUISHER LOCATIONS W/ VNER PRIOR TO INSTALLATION. ORK MUST BE WET CURED PER ACI REQUIREMENTS AND/OR CURED USING A EFER TO STRUCTURAL NOTES FOR CURING COMPOUND SPECS. CONTRACTOR IS LYING CURING COMPOUNDS PER THE MANUFACTURER'S REQUIREMENTS.

		TYP	ICAL ABBREVIATI	ONS		
ABV: Above	CIP: Cast-In-Place (Concrete)	EXCV: Excavate	HT: Height	MIN: Minimum	QTY: Quantity	TEL: Telephone
ACOUS:Acoustical	CL: Centerline	EXH: Exhaust	HC: Hollow Core	MIR: Mirror	QT: Quarry Tile	TEMP: Tempered
ADDL: Additional	CO: Clean Out	EXIST: Existing	HOR: Horizontal	MISC: Miscellaneous		TK: Tight Knot
ADH: Adhesive	CONTR:Contract (or)	EXT: Exterior	HB: Hose Bib	MOD: Module	RAD: Radius	T&G: Tongue and Groove
ADJ: Adjustable	COORD:Coordinate	FOO Frank (Ormanita	INT to the	MLD: Moulding	REF: Reference	T/O: Top of
AFF: Above Finish Floor	CRPT: Carpet	FOC: Face of Concrete	IN: Inch	MLB: Micro Laminate Beam	RFL: Reflect(ed),(ive),(or)	TOC: Top of Concrete
AGG: Aggregate	CIP: cast-in-place CLK: Caulking	FOF: Face of Finish FOM: Face of Masonry	INCL: Include ID: Inside Diameter	NOM: Nominal	REFR: Ref REG: Register	TOW: Top of Wall TB: Towel Bar
AHJ: Authority Having Jurisdiction A/C: Air Conditioning	CAS: Casement	FOM: Face of Masonry FOS: Face of Studs	ID: Inside Diameter INS: Insulate	NCM. North	REG: Register RE: Reinforced	T: Tread
ALT: Alternate	CB: Catch Basin	FOW: Face of Wall	INT: Interior	NIC: Not in Contract	REQ'D: Required	TS: Tubular Steel
ALUM: Aluminum	CLG: Ceiling	FBD: Fiberboard	INV: Invert	NTS: Not To Scale	RA: Return Air	TYP: Typical
ANC: Anchor, Anchorage	CT: Ceramic Tile	FCB: Fiber Cement Board	invoit	NO, #: Number	REV: Revision	in iypida
AB: Anchor Bolt	CIR: Circle	FGL: Fiberglass	JNT: Joint		R: Riser	UL: Underwriters Laboratory
ANOD: Anodized	CLR: Clear	FIN: Finish	JST: Joist	O: Non-Operable Window	RD: Rod	UNF: Unfinished
APX: Approximate	COL: Column	FFE: Finished Floor Elevation		Section	R&S: Rod and Shelf	UNO: Unless Noted Otherwise
APT: Apartment	CONC: Concrete	FA: Fire Alarm	KD: Kiln Dried	OBS: Obscure	RFG: Roofing	
ARCH: Architect (architectural)	CMU: Concrete Masonry Unit	FE: Fire Extinguisher	KIT: Kitchen	OC: On Center	RM: Room	VB: Vapor Barrier
ASPH: Asphalt	CONST:Construction	FPL: Fireplace		OP: Opaque	RO: Rough Opening	VAR: Varnish
AUTO: Automatic	CONT: Continuous	FLSH: Flashing	LB: Pound	OPG: Opening		VIF: Verify In Field
AVE: Avenue	CJT: Control Joint	FLR: Floor	LAM: Laminate(d)	OSB: Orientated Strand Board	SCH: Schedule	VRN: Veneer
AVR: Average	CORR: Corrugated	FLOR: Fluorescent	LAV: Lavatory	OD: Outside Diameter	SCN: Screen	VERT: Vertical
AWN: Awning	CUFT: Cubic Foot	FT: Foot, Feet	LH: Left Hand		SECT: Section	VG: Vertical Grain
	CUYD: Cubic Yard	FTG: Footing	L: Length	PMT: Paint(ed)	SGD: Sliding Glass Door	VIN: Vinyl Sheet
BSMT: Basement		FND: Foundation	LOA: Length Overall	PBD: Particle Board	SHTH: Sheathing	
BM: Beam	DP: Dampproofing	FRM: Fram(d), (ing)	LT: Light	PRT: partition	SHT: Sheet	WL: Wall
BVL: Beveled	DTL: Detail	FBO: Furnished by Others	LF: Lineal Feet	PVMT: Pavement	SH: Shelf, Shelving	WC: Water Closet
BITUM: Bituminous	DIA: Diameter	FUR: Furred	LL: Live Load	PERF: Perforate(d)	SIM: Similar	WH: Water Heater
BLK: Block	DIM: Dimension		LVL: Laminated Veneer Lumber	PLAS: Plaster	SKL: Skylight	WP: Water Proofing
BLKG: Blocking BLW: Below	DW: Dishwasher DIV: Division	GA: Gage, Gauge GAL: Gallon	LVR: Louver	PLAM: Plastic Laminate PLT: Plate	S: South SLB: Slab	WR: Weather Resistant WRB: Weather Resistive
BLW: Below BLDV: Boulevard	DR: Door	GAL: Gallon GL: Glass, Glazing	MFR: Manufacturer	PLT. Plate PLYWD: Plywood	SLD: Slider(ing)	Barrier
BTW: Between	DH: Double Hung	GI: Galvanized Iron	MO: Masonry Opening	PCC: Precast Concrete	SPEC: Specification	WWF: Welded Wire Fabric
BD: Board	DS: Downspout	GLBK: Glass Block	MAX: Maximum	PCF: Pounds Per Cubic Foot	SQ: Square	WWM: Welded Wire Mesh
BOT: Bottom	DRWR: Drawer	GLB: Glue Laminated Beam	MAS: Masonry	PLF: Pounds Per Linear Foot	STD: Standard	W: West
BLDG: Building	DT: Drain Tile	GT: Grout	MECH: Mechanic(al)	PSF: Pounds Per Square Foot	STV: Stove	WIN: Window
BUR: Built Up Roofing	DWG: Drawing	GRD: Grade, Grading	MC: Medicine Cabinet	PSI: Pounds Per Square Inch	STL: Steel	W/O: Without
B/O: By Others	D: Nail Size	GWB: Gypsum Wall Board	MED: Medium	PBF: Prefabricated	STR: Structural	W/: With
BO: Bottom Of			MDF: Medium Density Fiberboard		SA: Supply Air	WD: Wood
BR: Bedroom	EW: Each Way	HWD: Hardware	MDO: Medium Density Overlay	PT: Pressure Treated	SC: Solid Core	
	E: East	HDR: Header	MBR: Member	PL: Property Line	SW: Shear Wall	X: Operable Window Section
CAB: Cabinet	EL: Elevation	HTG: Heating	MMB: Membrane	PH: Toilet Paper Hanger	SS: Stainless Steel	
CALC: Calculation	ELEV: Elevation	HVAC: Heating,	MTL: Metal		SYS: System	
CD: Cabinet Door	EQ: Equal	Ventilation-Air Conditioning	MWK: Millwork			
CG: Corner Guard	EQP: Equipment					

PROJECT CONTACT INFO

259 SOUTH STREET, SUITE A WAUKESHA, WI 53186

ARCHITECT:

THRIVE ARCHITECTS

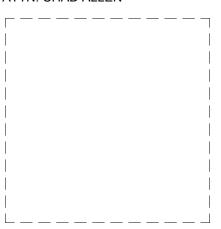
OWNER: MENOMINEE TRIBAL ENTERPRISES HWY 47 NORTH N3580, BIA RTE 427 NEOPIT, WI 54150

LUMBER EQUIPMENT CONSULTANT: ENGINEER NAME STREET ADDRESS CITY, WI ##### P: ###-###-#### ATTN: JOHN KANTOLA



STRUCTURAL ENGINEER: OTIE

1033 N MAYFAIR RD. #200 MILWAUKEE, WI 53226 P: 414-257-4200 ATTN: CHAD ALLEN



EGRESS WIDTH			
# OF OCCUPANTS	EGRESS WIDTH FACTOR	EGRESS WIDTH REQUIRED	EG
94 OCCUPANTS	.2 INCHES PER OCCUPANT	32" MIN. CLEAR WIDTH	

OCCUPANT LOAD

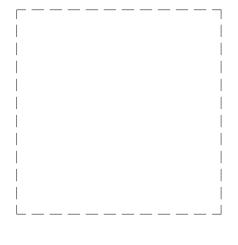
OCCUPANT LOAD PER TABLE 1004.1.2

OCCUPANT LOAD PER TABLE 1004.1.2					
ROOM & OCCUPANCY LEVEL		FLOOR AREA / SF	DENSITY SF / PERSON	OCCUPANT LOAD	
INDUSTRIAL AREA (F-1)	FIRST FLOOR	9,396 S.F.	100/GROSS	94	
	TOTAL	9,396 S.F.		94	





CIVIL ENGINEER: OTIE 1033 N MAYFAIR RD. #200 MILWAUKEE, WI 53226 P: 414-257-4200 ATTN: JOHN THOUSAND



MEP ENGINEER: OES GROUP 1033 N MAYFAIR RD. #200 MILWAUKEE, WI 53226 P: 414-257-4200 ATTN: MARI WESTIN

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ARCH TECTS Architect 259 South Street, Suite A Waukesha, WI 53186 p: 833.380.6180	
Project Info. 24034 MTE GREEN STACKER 06-79-06442 URI: 121212 NEW CONSTRUCTION Hwy 47 North n 3580, BIA Rte 427 Neopit, WI 54150	
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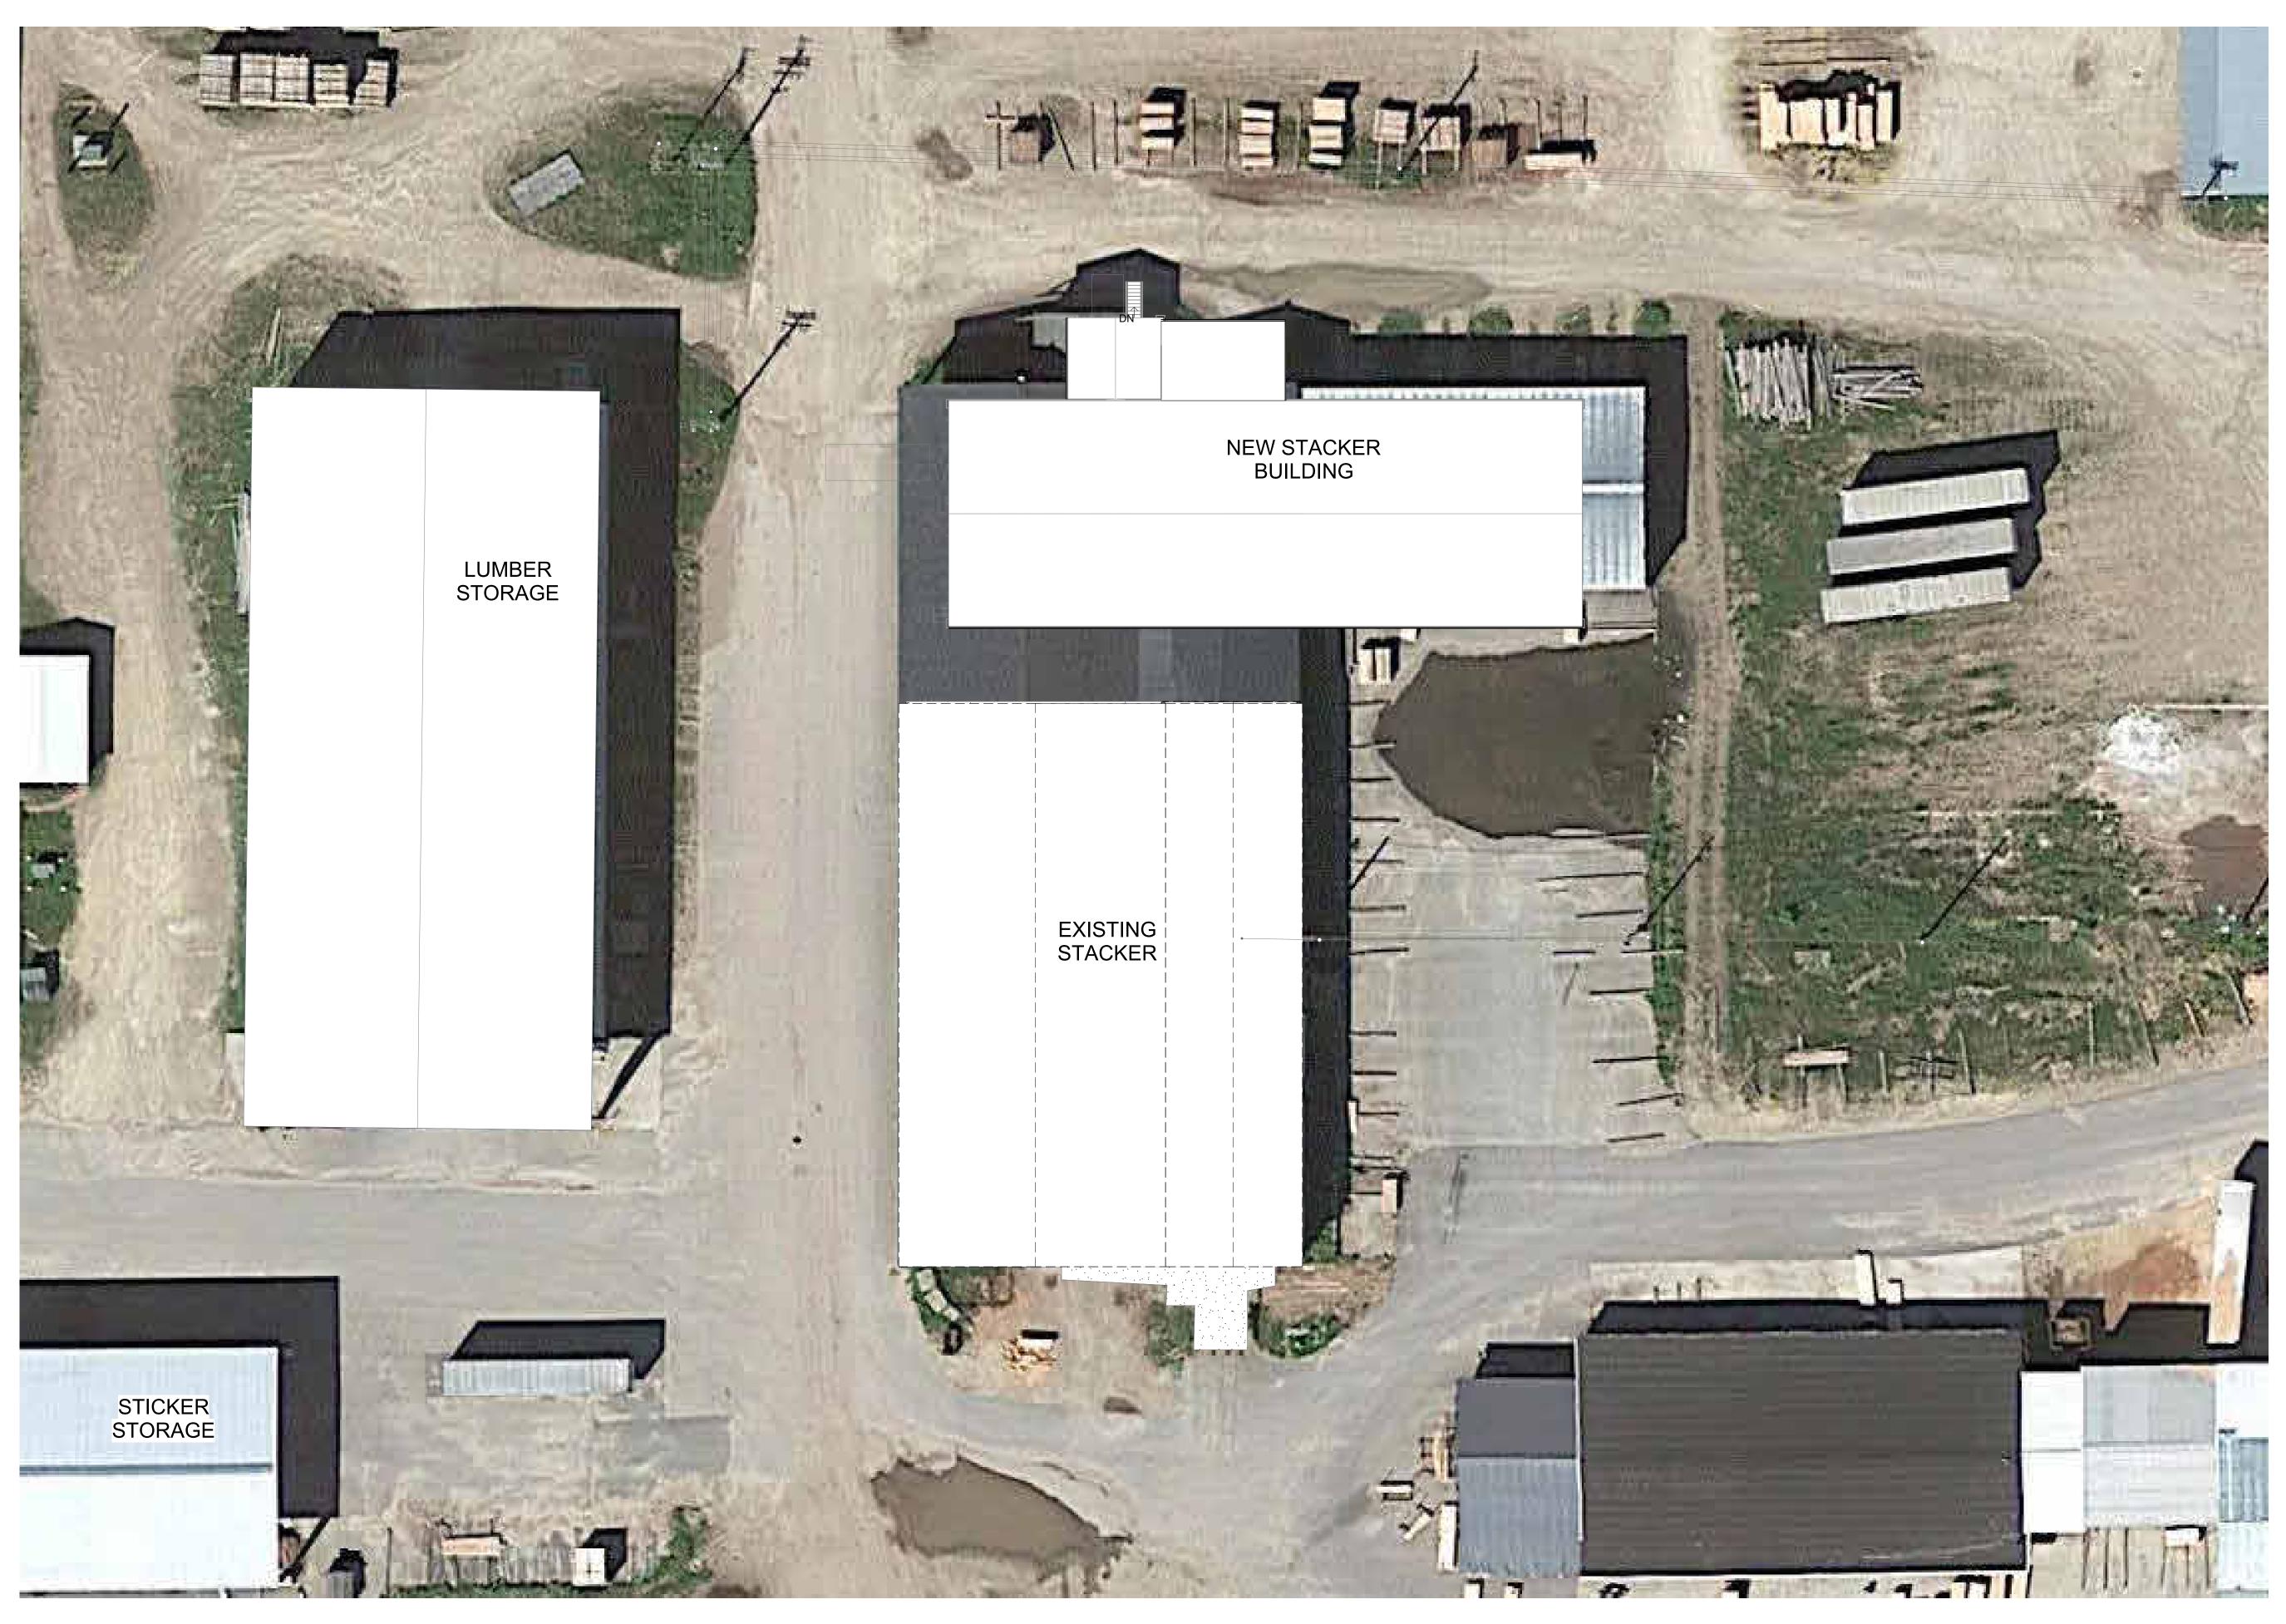
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VICINITY MAP 12" = 1'-0"





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- Project Info. -----24034----

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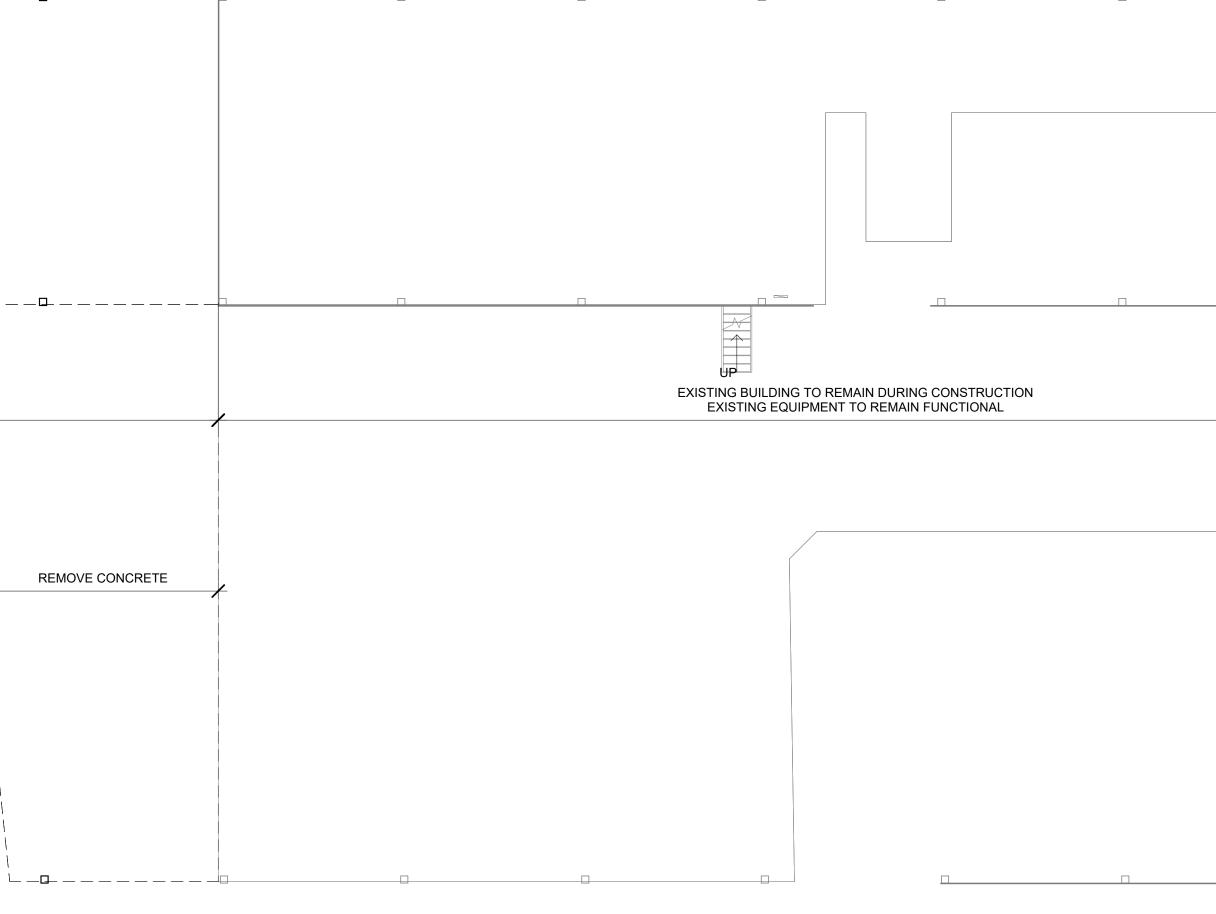
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DEMO BUILDING(S) AND STRUCTURE THIS AREA

1 PHASE 1 DEMOLITION PLAN 3/32" = 1'-0"



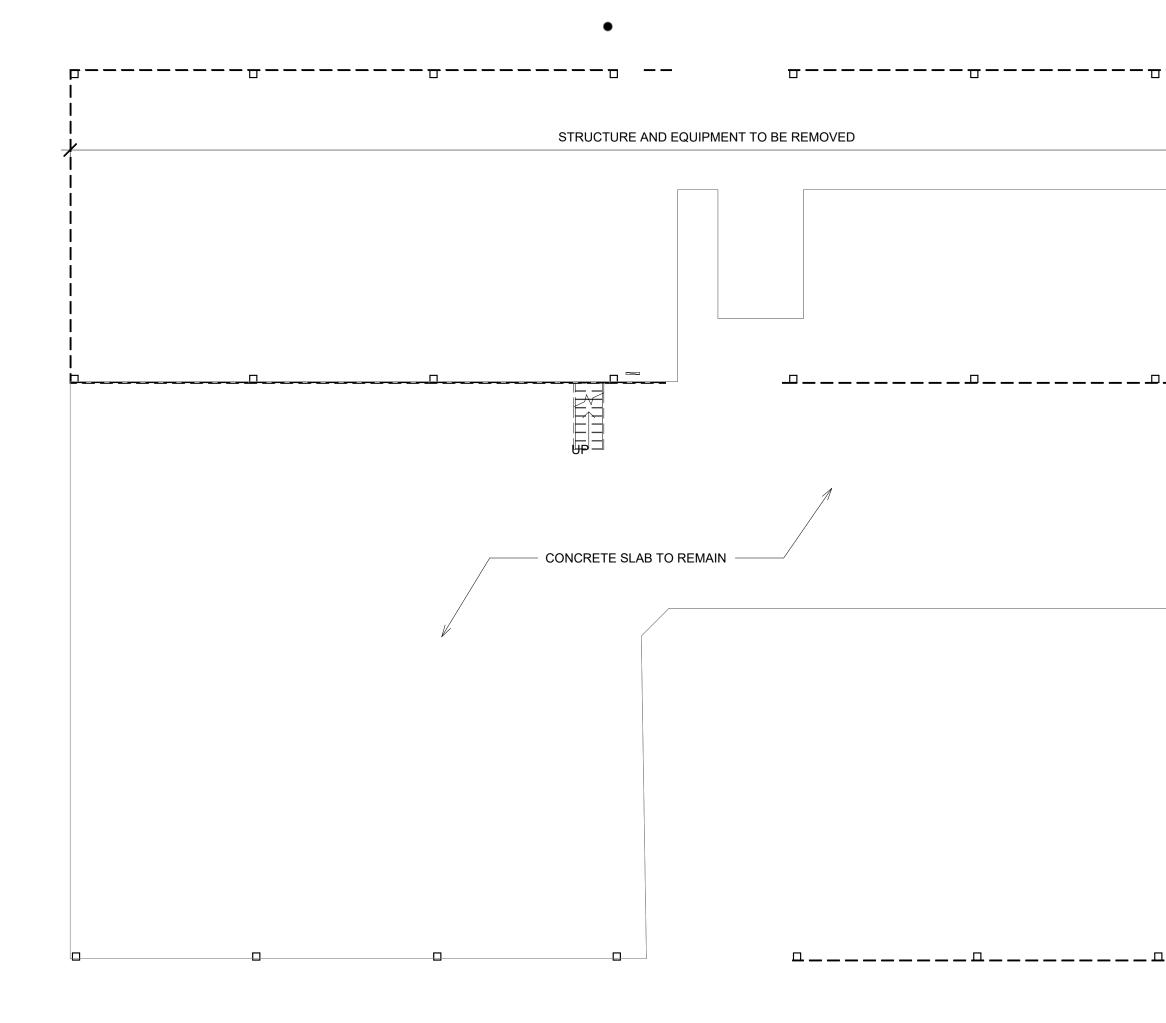
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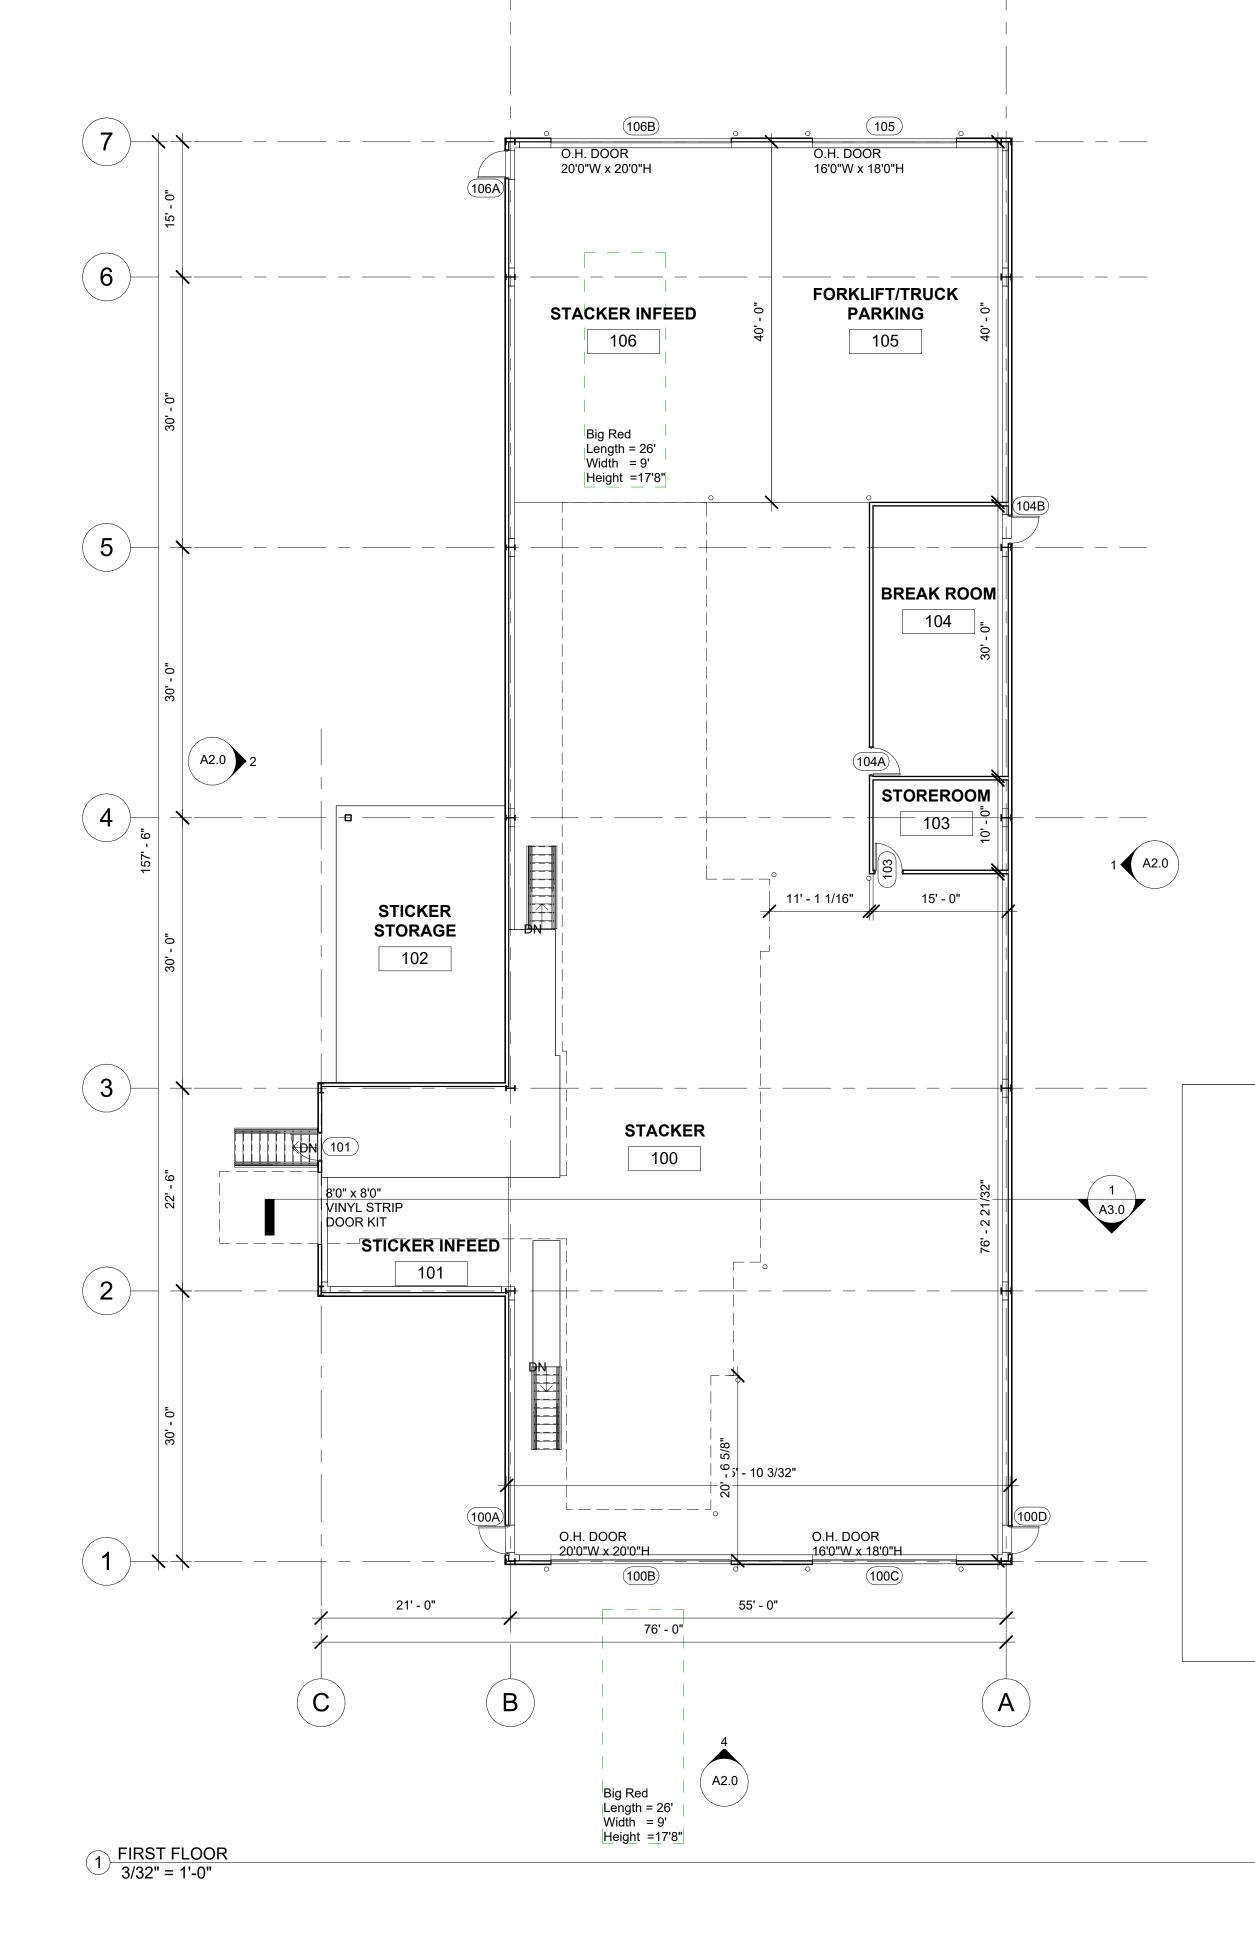
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			53186 24034 EEN R VRI: 121212 CTION 3580,
		DEMOLITION PLAN - PHASE 2	
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EXISTING CONCRETE SLAB

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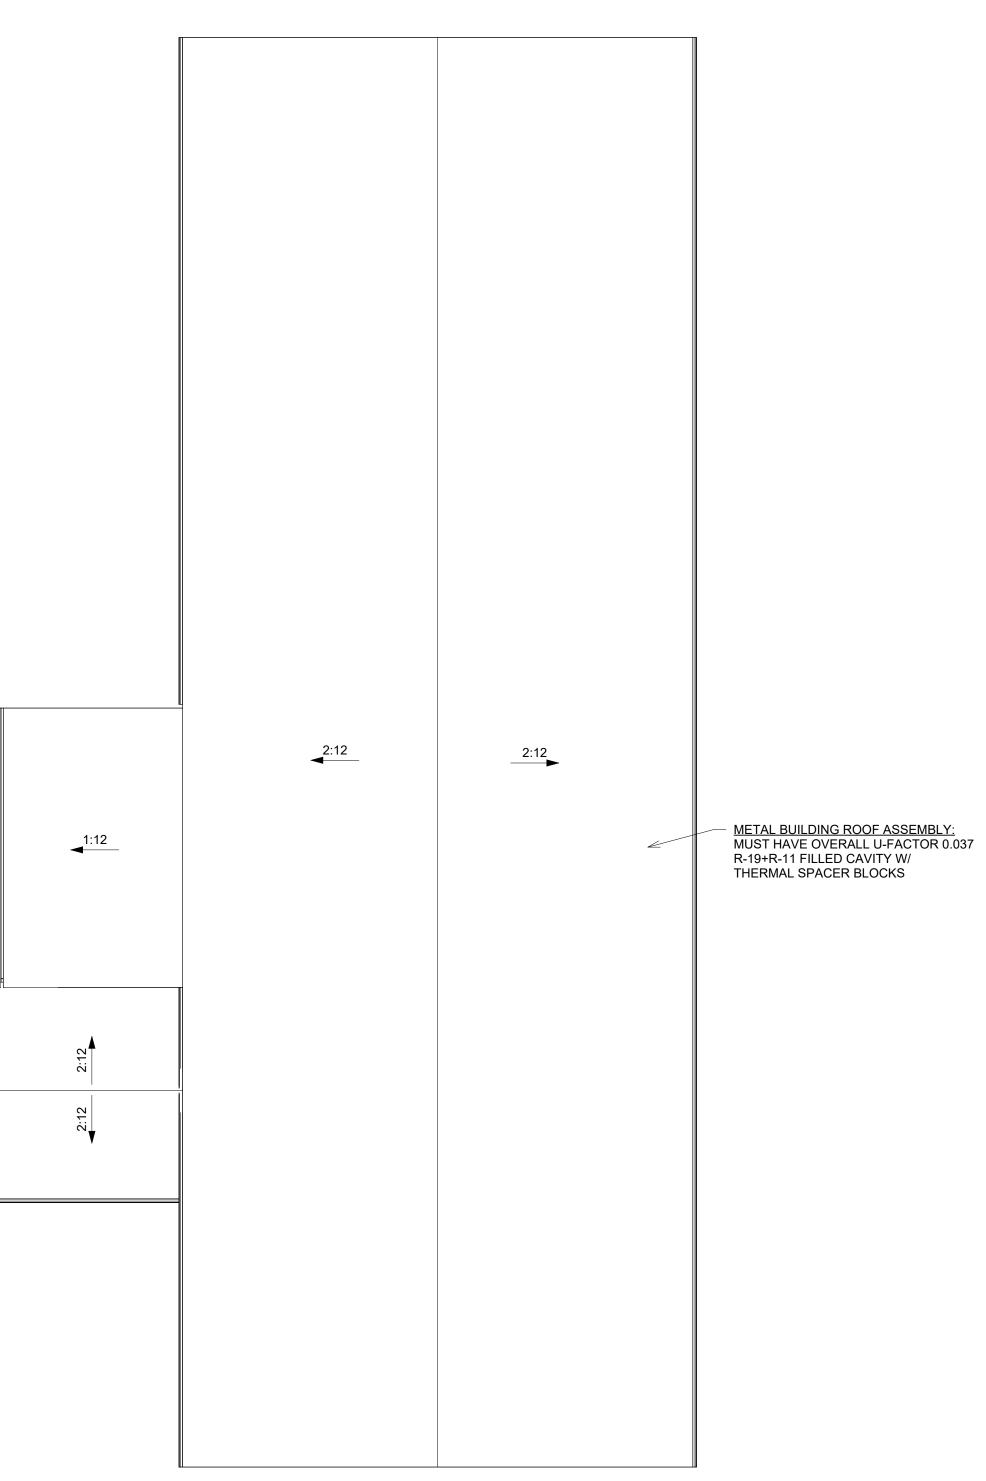
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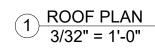
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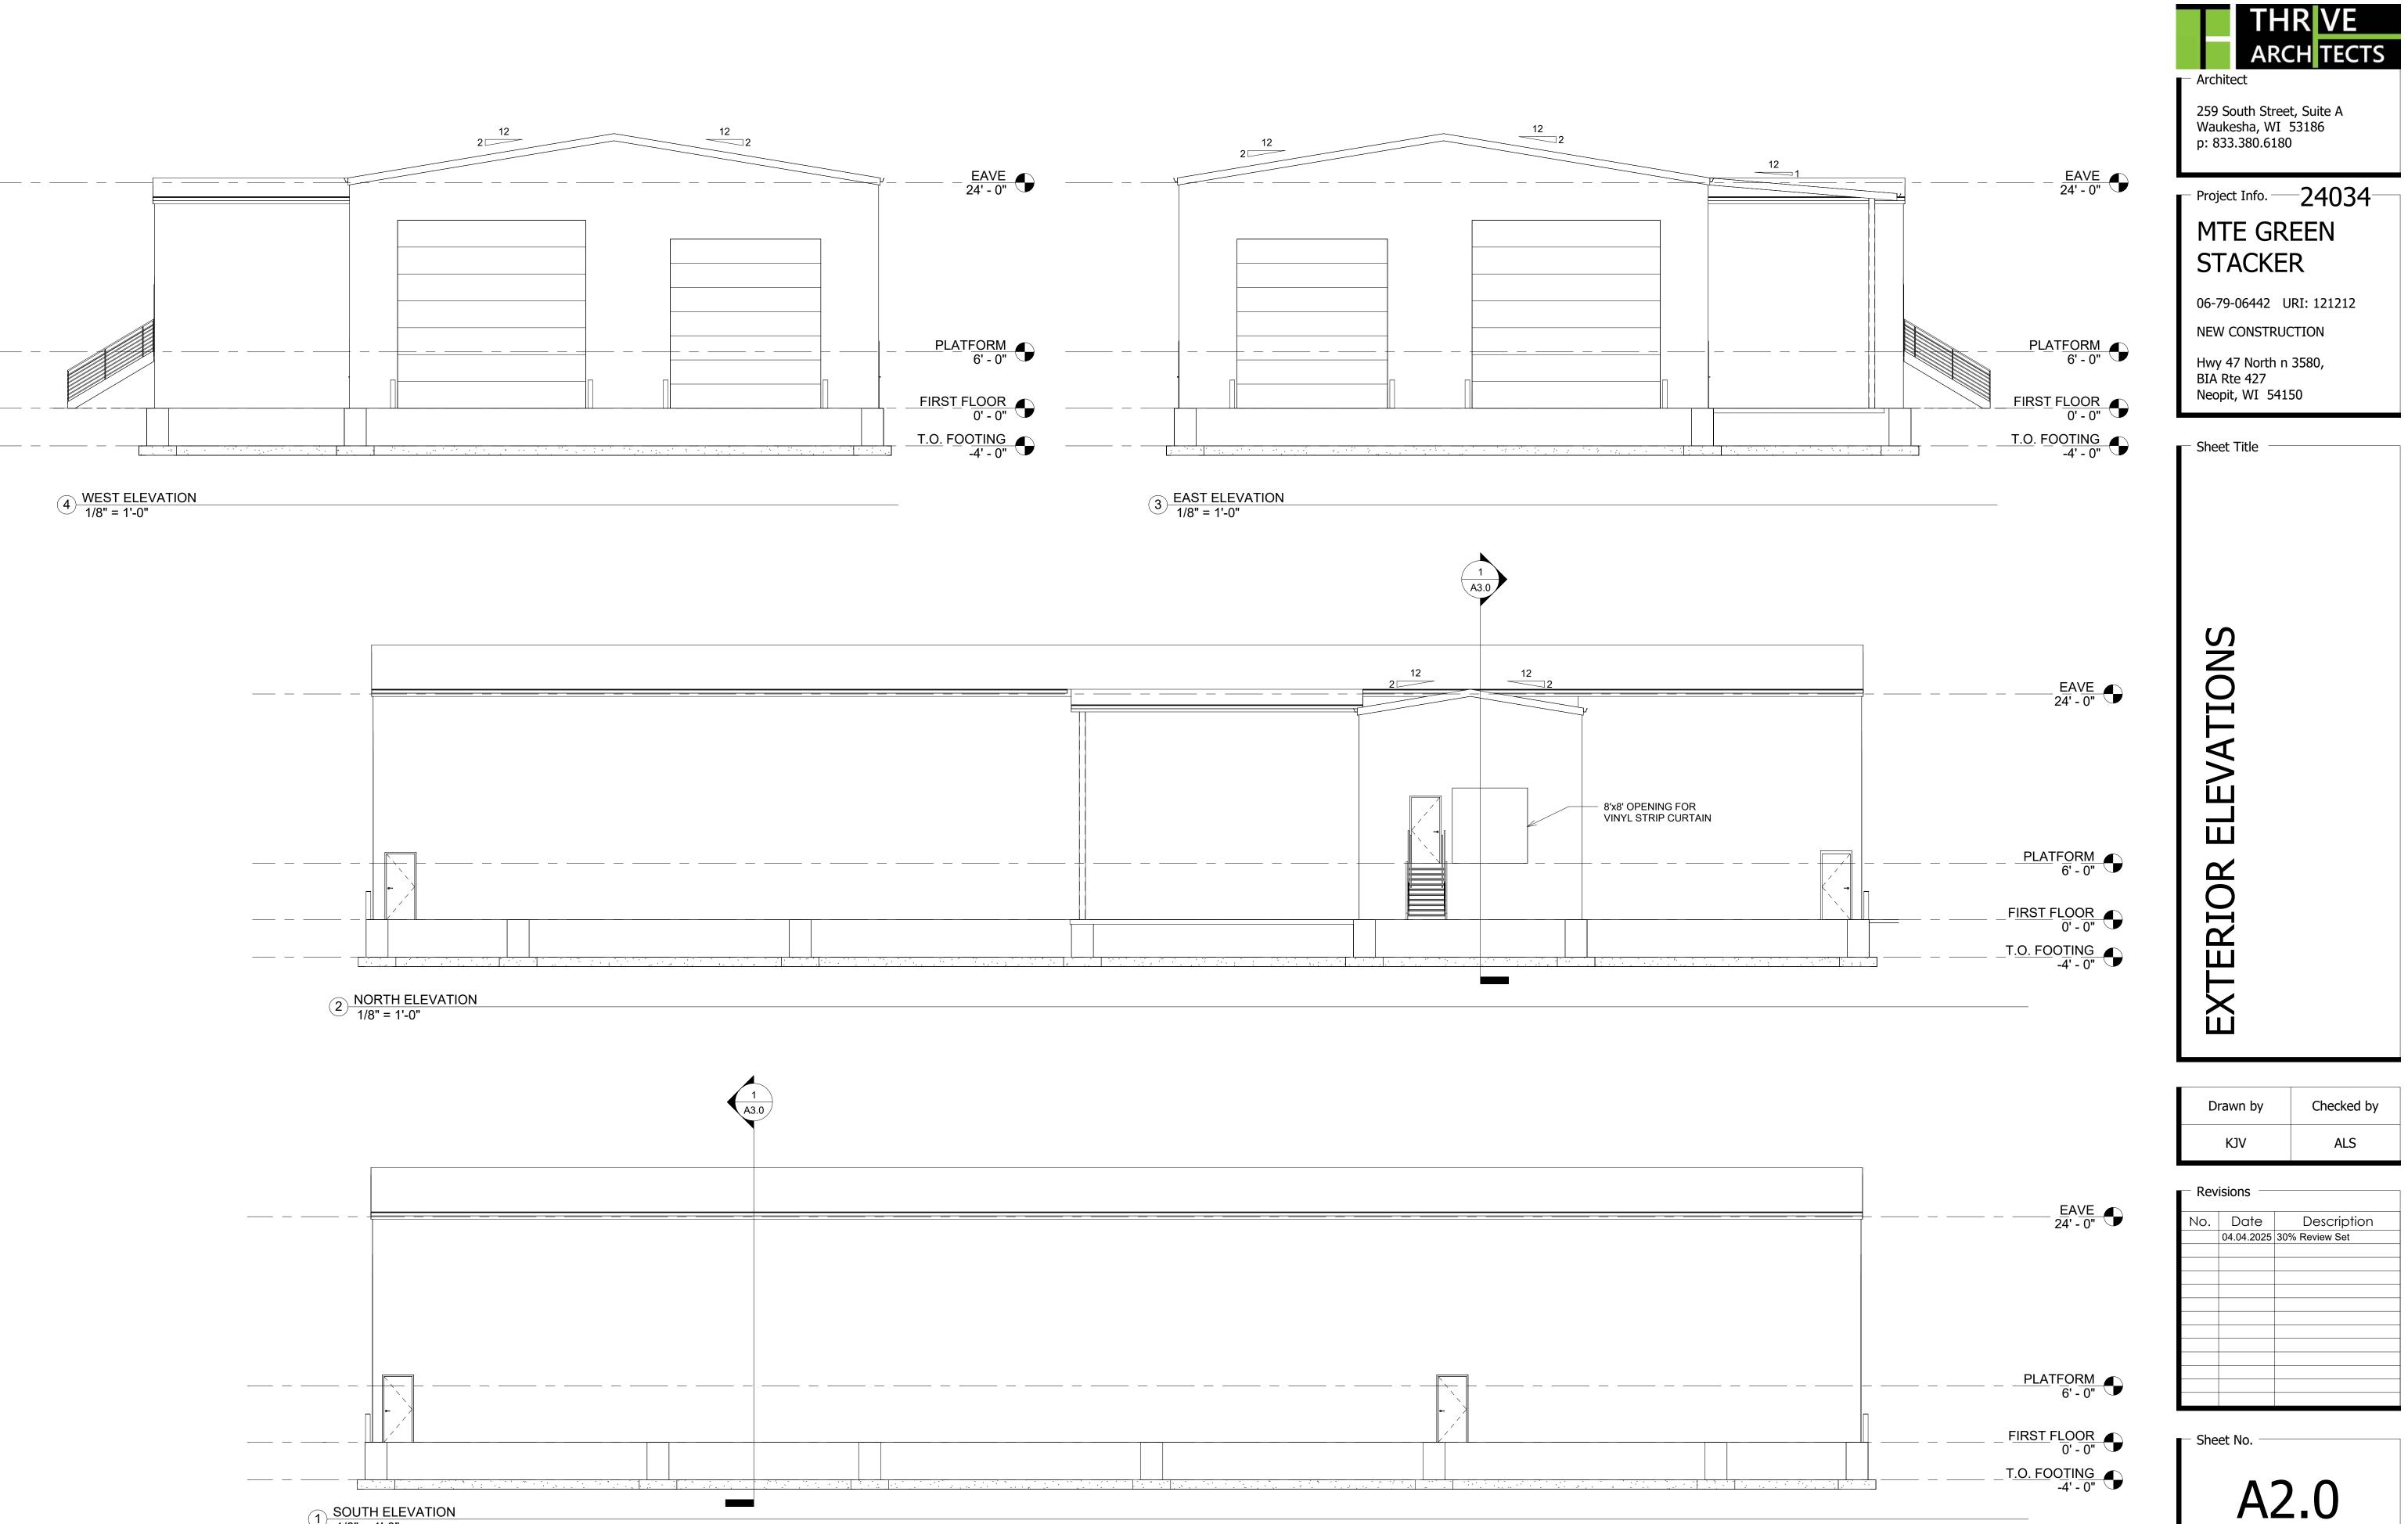
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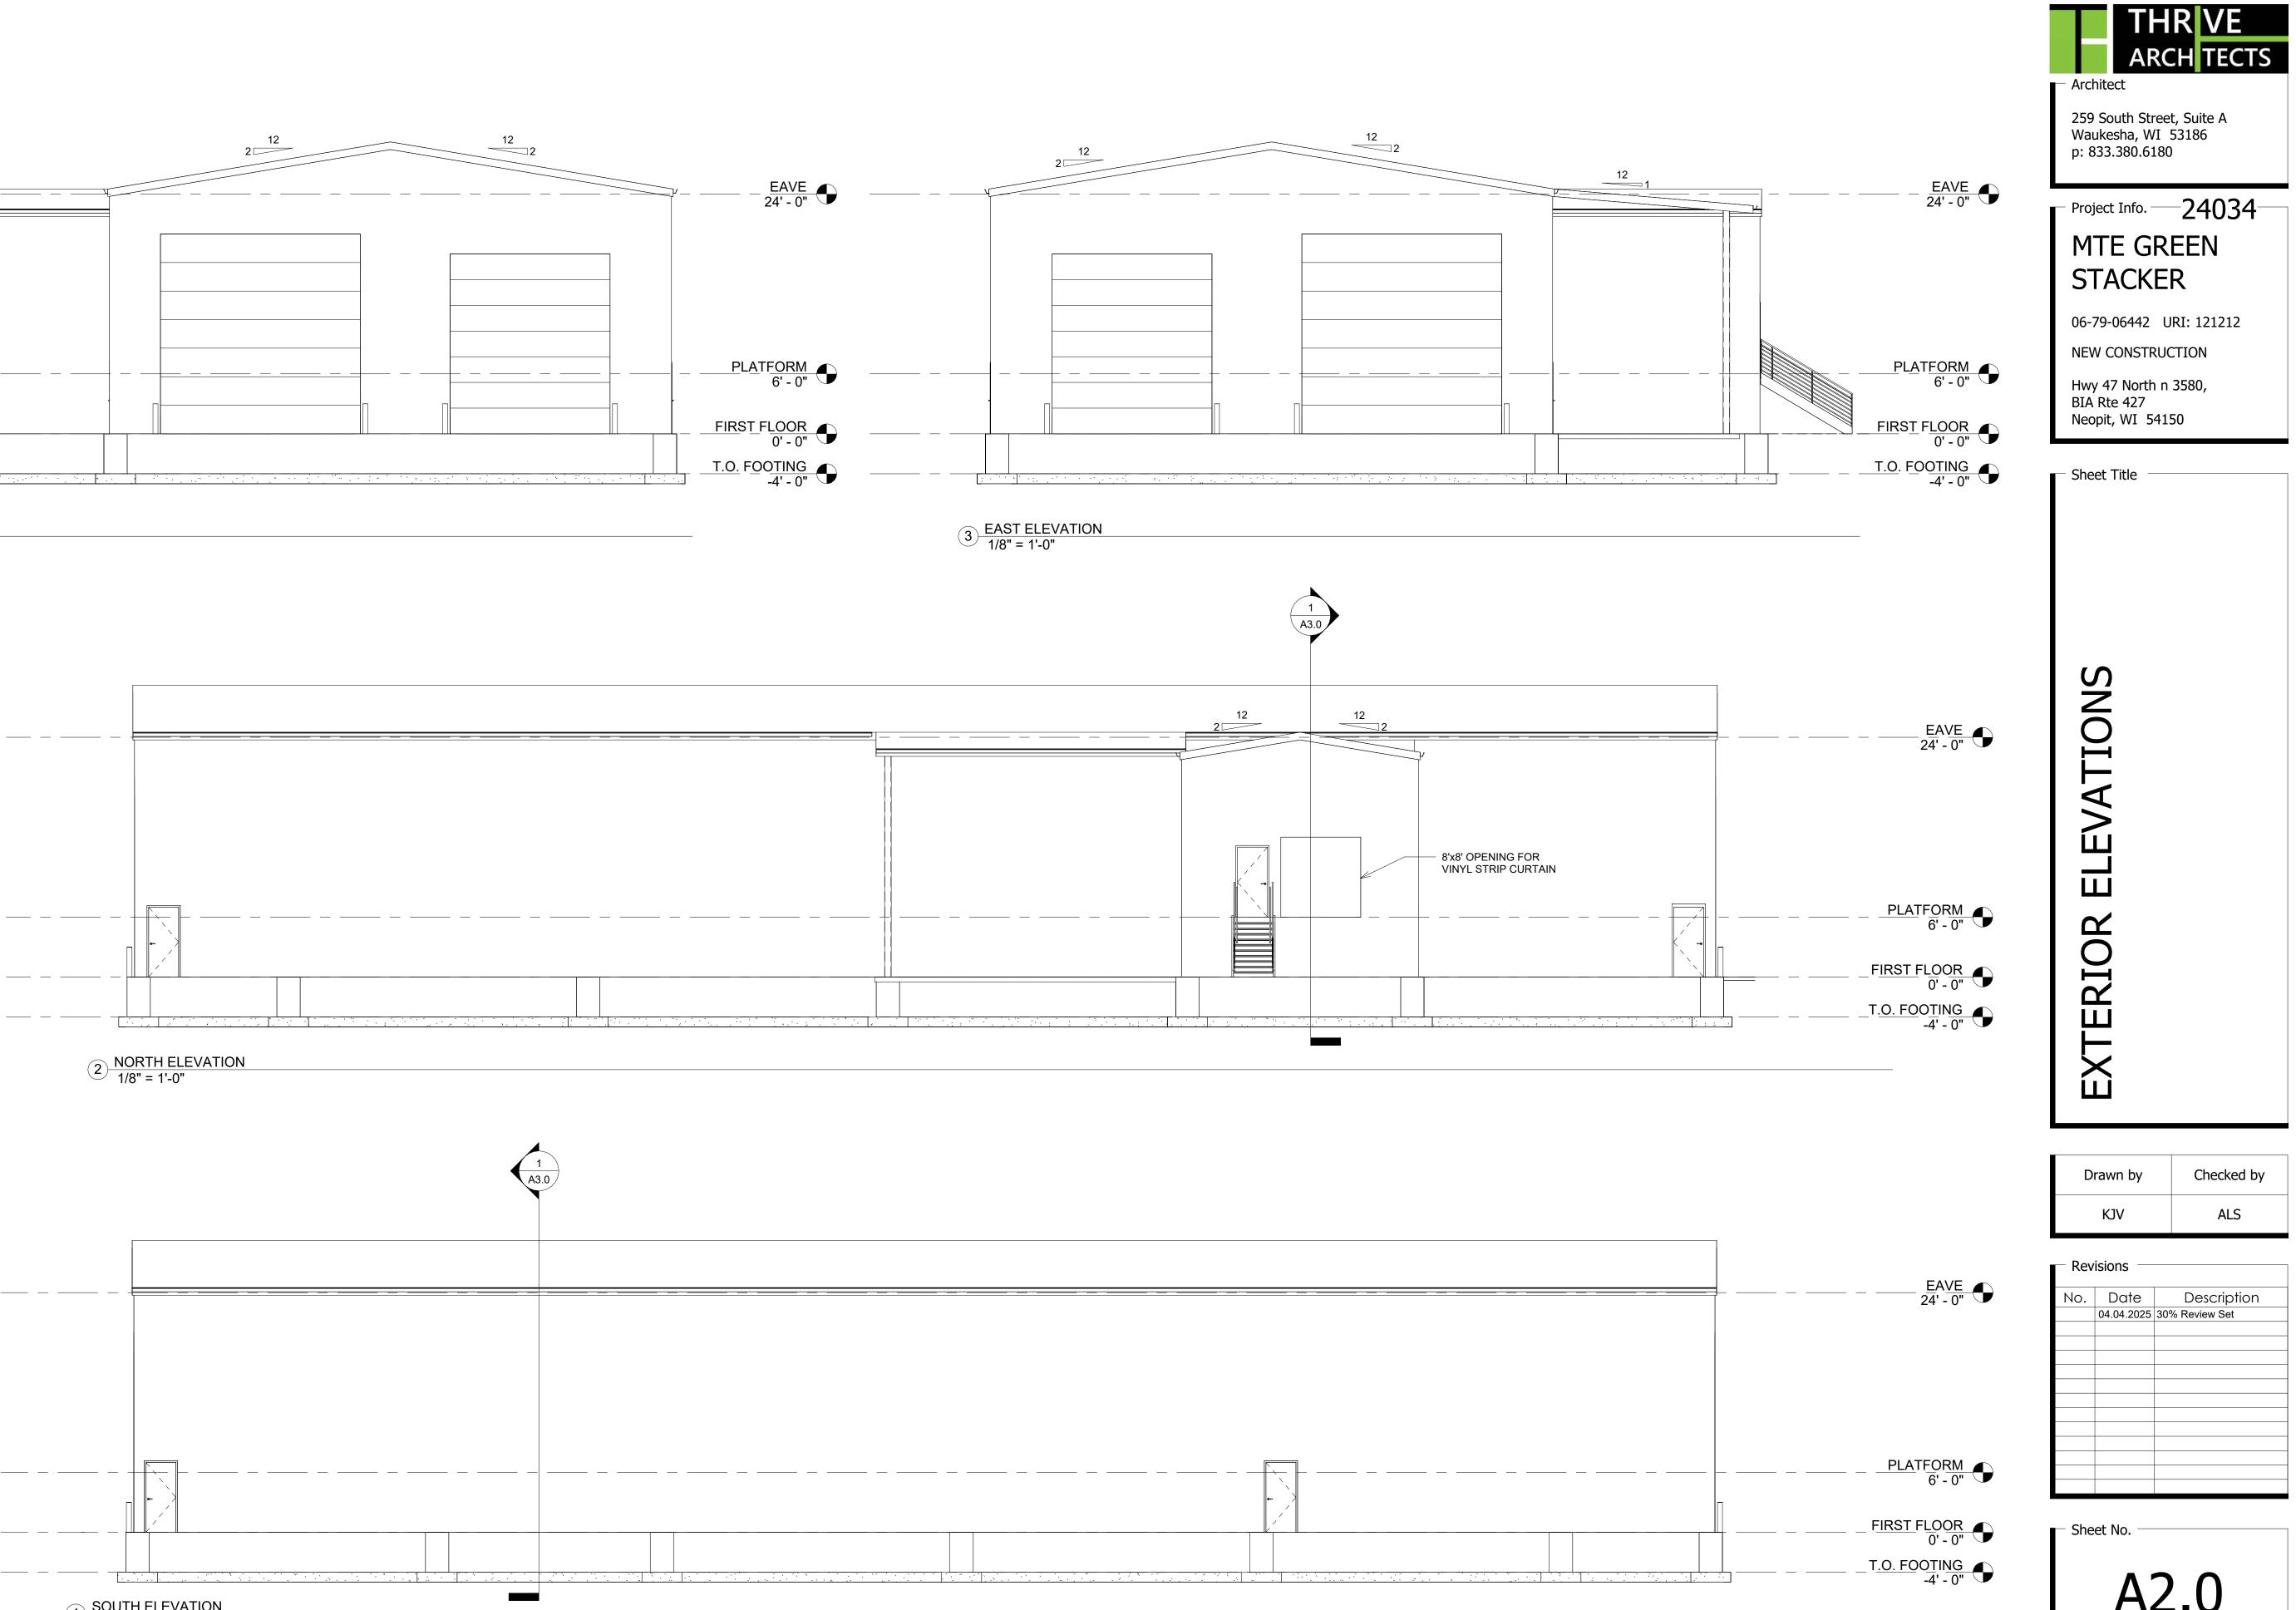
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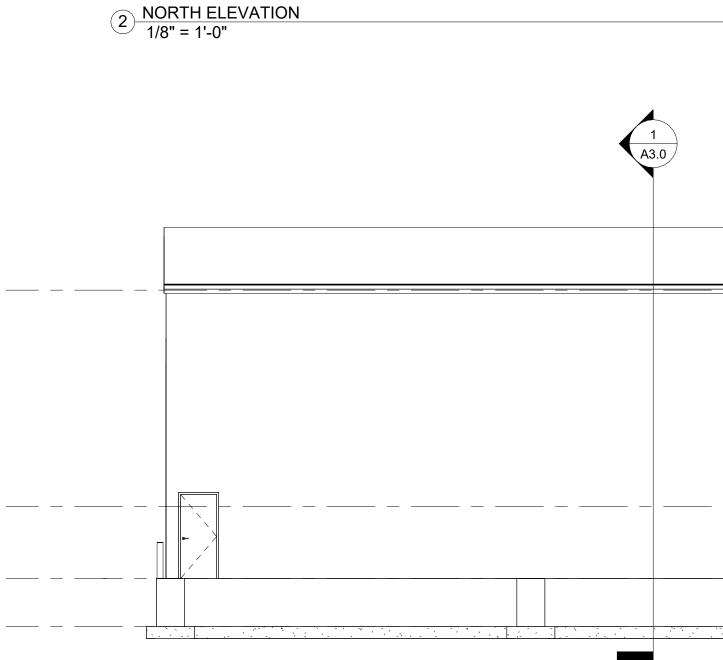
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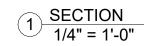
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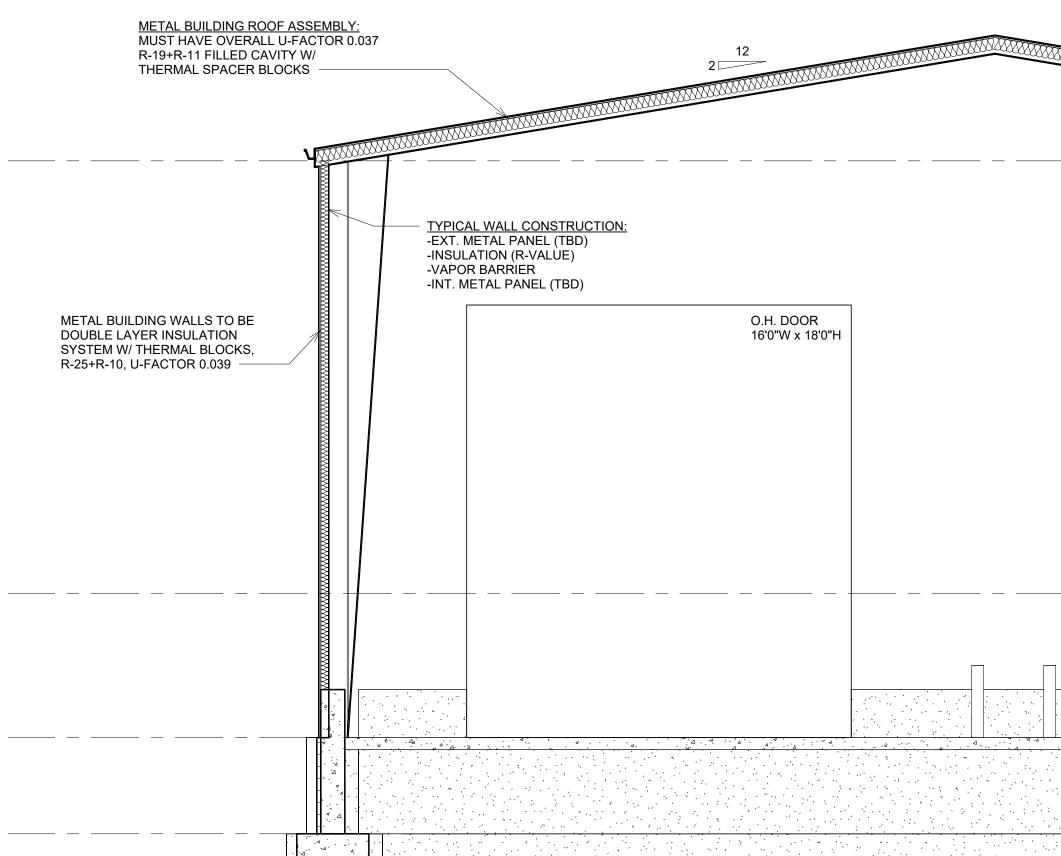






1 <u>SOUTH ELEVATION</u> 1/8" = 1'-0"





EQUIPMENT BY OWNER				
	18'0"W x 20'0"H		EQUIPMENT BY OWNER	VINYL STRIP CURTAIN AT 8'x8' OPENING

THR VE ARCH TECTS Architect 259 South Street, Suite A Waukesha, WI 53186 p: 833.380.6180
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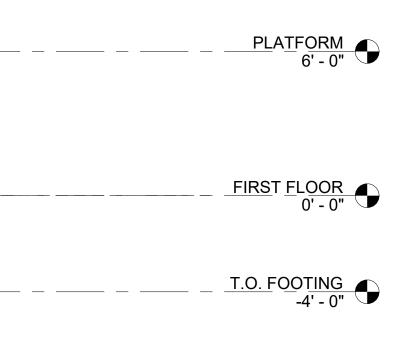
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_EAVE 24' - 0"



Room Schedule									
Room Number	Room NumberRoom NameFloor FinishBase FinishWall FinishCeiling FinishCeiling HeightComments								
100 BREAK ROOM									
101	STOREROOM								

Door Schedule								
DOOR NUMBER	NO. OF PANELS		R SIZE HEIGHT	DOOR TYPE	FRAME TYPE	FIRE RATING	REMARKS	
100A	1	3' - 0"	7' - 0"			_		
100A	O.H. DOOR	20' - 0"	20' - 0"	-	-	-	U-FACTOR 0.2	
100C	O.H. DOOR	16' - 0"	18' - 0"	-	-	-	U-FACTOR 0.2	
100D	1	3' - 0"	7' - 0"			-		
101	1	3' - 0"	7' - 0"			-		
103	1	3' - 0"	7' - 0"			-		
104A	1	3' - 0"	7' - 0"			-		
104B	1	3' - 0"	7' - 0"			-		
105	O.H. DOOR	16' - 0"	18' - 0"	-	-	-	U-FACTOR 0.2	
106A	1	3' - 0"	7' - 0"			-		
106B	O.H. DOOR	20' - 0"	20' - 0"	-	-	-	U-FACTOR 0.2	



Architect

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Project Info. 24034

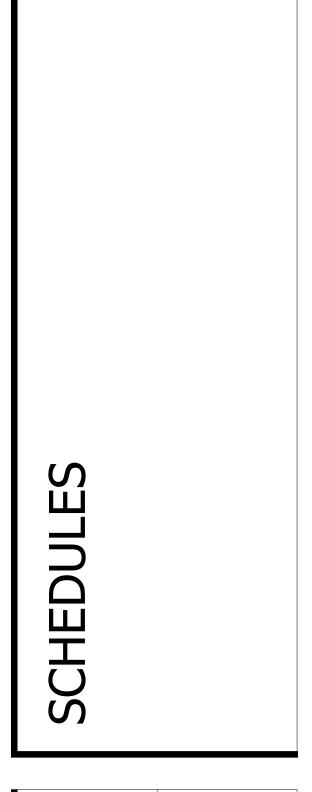
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06-79-06442 URI: 121212

NEW CONSTRUCTION

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